DEVELOPMENT SERVICES

JEREMY DYE, ASSISTANT DIRECTOR

CARRIE HOLMES, CHIEF BUILDING OFFICIAL

DAVID C. WILLIAMS, DIRECTOR

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REVIEWED FOR DESIGN CRITERIA ONLY

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SHEET NO:

BOARD OF SUPERVISORS

CRAIG BROWN, CHAIRMAN - DISTRICT 4 JAMES GREGORY, MEMBER - DISTRICT 2 HARRY B. OBERG, MEMBER - DISTRICT 1 DONNA G. MICHAELS, Ph.D., MEMBER - DISTRICT 3 MARY MALLORY, VICE-CHAIR - DISTRICT 5



Single-Family Housing THREE BEDROOM / TWO BATH - RIGHT PARKING

YAVAPAI COUNTY, ARIZONA

1015 Fair Street Prescott, Arizona

GENERAL NOTES

1. DUE TO REPROGRAPHIC PROCESS, THESE PLANS MAY NOT BE SCALED FROM THE WORKING DRAWINGS.

2. BEFORE ORDERING ANY MATERIALS OR STARTING ANY WORK, CONTRACTORS SHALL VERIFY ALL MEASUREMENTS AND EXISTING CONDITIONS AT THE SITE AND SHALL BE RESPONSIBLE FOR THE CORRECTNESS OF THE SAME. ANY DEVIATION AND/OR UNSAFE OR UNREGULATED CONDITIONS SHALL BE BROUGHT TO THE ATTENTION OF YAVAPAI COUNTY DEVELOPMENT SERVICES.

3. GENERAL CONTRACTOR TO VERIFY AND LOCATE ALL UTILITY STUB OUTS AND MAINS BEFORE BEGINNING CONSTRUCTION OF PROJECT.

4. GENERAL CONTRACTOR TO VERIFY THE REMOVAL AND/OR REPLANTING OF LANDSCAPE IF THE CONDITION OCCURS OVER THE PROJECT SITE. 5. DAMAGE TO SITE, UTILITIES, OR NEWLY BUILT IMPROVEMENTS, NOT DESIGNED FOR REMOVAL, SHALL BE THE RESPONSIBLITY OF THE GENERAL CONTRACTOR INVOLVED, AND SHALL BE REPAIRED OR REPLACED AT THE

EXPENSE OF THE SAME. 6. VERIFY UNIFORMITY OF ALL FRAMING SO AS TO CREATE A SMOOTH, REGULAR FINISH WITH NO IRREGULARITIES.

1. IT IS THE RESPONSIBILITY OF THE GENRAL CONTRACTOR, TO THOROUGHLY REVIEW THE PLANS AND TO NOTIFY YAVAPAI COUNTY DEVELOPMENT SERVICES OF ANY DISCREPANCIES. YAVAPAI COUNTY, NOR THE ARCHITECT-OF-RECORD, WILL NOT BE RESPONSIBLE FOR MATERIALS IMPROPERLY ORDERED OR INSTALLED

8. FAILURE BY THE GENERAL CONTRACTOR, OR SUB-CONTRACTORS, TO AQUAINT THEM-SELVES WITH ALL AVAILABLE INFORMATION CONCERNING THIS PROJECT SHALL NOT RELIEVE THEM OF THE RESPONSIBILITY TO PERFORM THEIR WORK PROPERLY.

- 9. APPROVAL OF ALL CONSTRUCTION IS SUBJECT TO FIELD VERIFICATION BY YAVAPAI COUNTY PERSONELL.
- 10. EVERY SLEEPING ROOM SHALL HAVE AT LEAST ONE (1) OPERATING WINDOW, OR DOOR, FOR EMERGENCY EGRESS, OPEN DIRECTLY TO A STREET, ALLEY, OR YARD.
- 11. ALL INTERIOR WALL, AND CEILING FINISHES, SHALL BE TAPED, TEXTURED, AND PAINTED 1/2" DRYWALL. PROVIDE 'GREENBOARD' BEHIND ALL TUB ENCLOSURES.

INDEX TO DRAWINGS

7:							
	CS	COVER SHEET					
	A-1.0	PROJECT INFO / FLOOR PLAN / OPENING SCHEDULES					
	A-1.1	GARAGE ALTERNATE SHEET					
	A-2.0	FOUNDATION PLAN / DETAILS					
	A-3.0	ROOF FRAMING PLAN / DETAILS					
	A-4.0	EXTERIOR ELEVATIONS / BLDG. SECTION					
	ME-1	HVAC / ELECTRICAL PLANS					

PROJECT INFORMATION

ALL WORK SHALL CONFORM TO ALL YAVAPAI COUNTY ADOPTED CODES, ORDINANCES AND POLICIES, INCLUDING BUT NOT LIMITED TO THE FOLLOWING 2018 INTERNATIONAL RESIDENTIAL CODE (IRC) 2018 INTERNATIONAL PLUMBING CODE (IPC) 2018 INTERNATIONAL MECHANICAL CODE (IMC) 2017 NATIONAL ELECTRIC CODE (NEC)

2006 INTERNATIONAL ENERGY CONSERVATION CODE (IECC) LIVABLE: 1,300 SQ. FT. COVERED ENTRY: 65 SQ. FT. CARPORT: 400 SQ. FT.

STORAGE: 62 SQ. FT. TOTAL UNDER ROOF: 1,827 SQ. FT. OCCUPANCY: R-3 (Single-Family Residential)

CONSTRUCTION TYPE: V-B

12/08/2021

YAVAPAI COUNTY BUILDING DEPT. () REVIEWED FOR CODE COMPLIANCE

THE ISSUANCE OF A PERMIT BASED ON PLANS, SPECIFICATIONS, AND OTHER DATA, SHALL NOT PREVENT THE BUILDING OFFICIAL FROM THEREAFTER REQUIRING THE CORRECTION OF ERRORS IN SAID PLANS, SPECIFICATIONS, AND OTHER DATA, OR FROM PREVENTING BUILDING OPERATIONS BEING CARRIED ON THEREAFTER, WHEN IN VIOLATION OF THIS CODE OR ANY OTHER ORDINANCES OF THIS JURISDICTION - SEC. 105.4

() REVIEWED AS NOTED WITH CORRECTION ENGINEERING REVIEWED FOR DESIGN CRITERIA ONLY

EFFECTIVE APRIL 20, 2006 **FULLY SHIELDED FIXTURES ARE** REQUIRED FOR ALL EXTERIOR LAMPS

POSITIVE DRAINAGE AWAY FROM THE STRUCTURE IS REQUIRED

12/08/2021 Luis Tamayo SPECIAL INSPECTION REQUIRED REFER TO THE GEOTECHNICAL REPORT FOR ANY Reports to be supplied to **Building Inspector** ADDITONAL REQUIREMENTS

PER GEOTECH REQUIREMENTS

Yavapai County permitted building plans do not relieve the Owners or General Contractor from their responsibilities to conform to all adopted building codes. Every effort has been made to provide a thorough plan review, however plans may contain irregularities. If plans do not contain the proper information or details the Owner/General Contractor Shall Not proceed with the project until the issue has been resolved through Yavapai County and any professional involved in the project.


CAUTION


Yavapai County Ordinance, Section 112.6 Drainage across Property Lines. Drainage across property lines shall not exceed that which existed prior to grading. Excess or concentrated drainage shall be contained on site or directed to an approved drainage facility. Erosion of the ground in the area of discharge shall be prevented by installation of non-erosive

The inspector may require further clarification on stamped plans. This may include, but not limited to a special down-drains or other devices.


inspection and /or a cross section detail stamped and signed by the Designer/Architect/Engineer of record.

PROPERTY OF YAVAPAI COUNTY, AZ

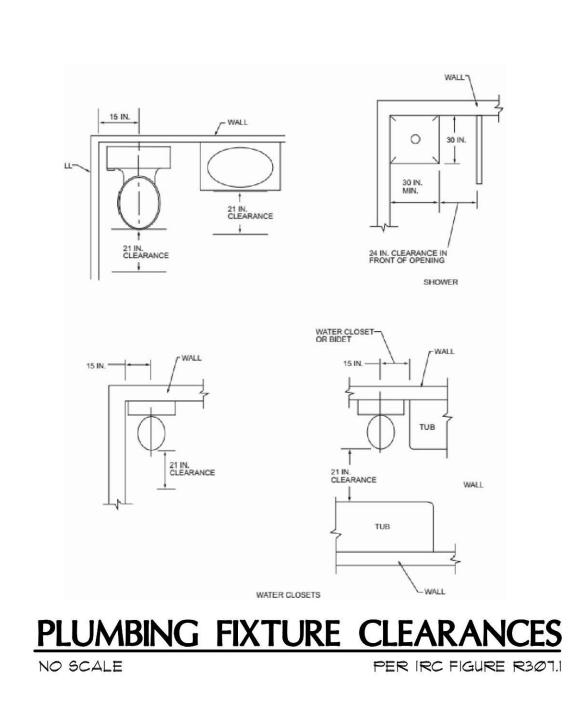

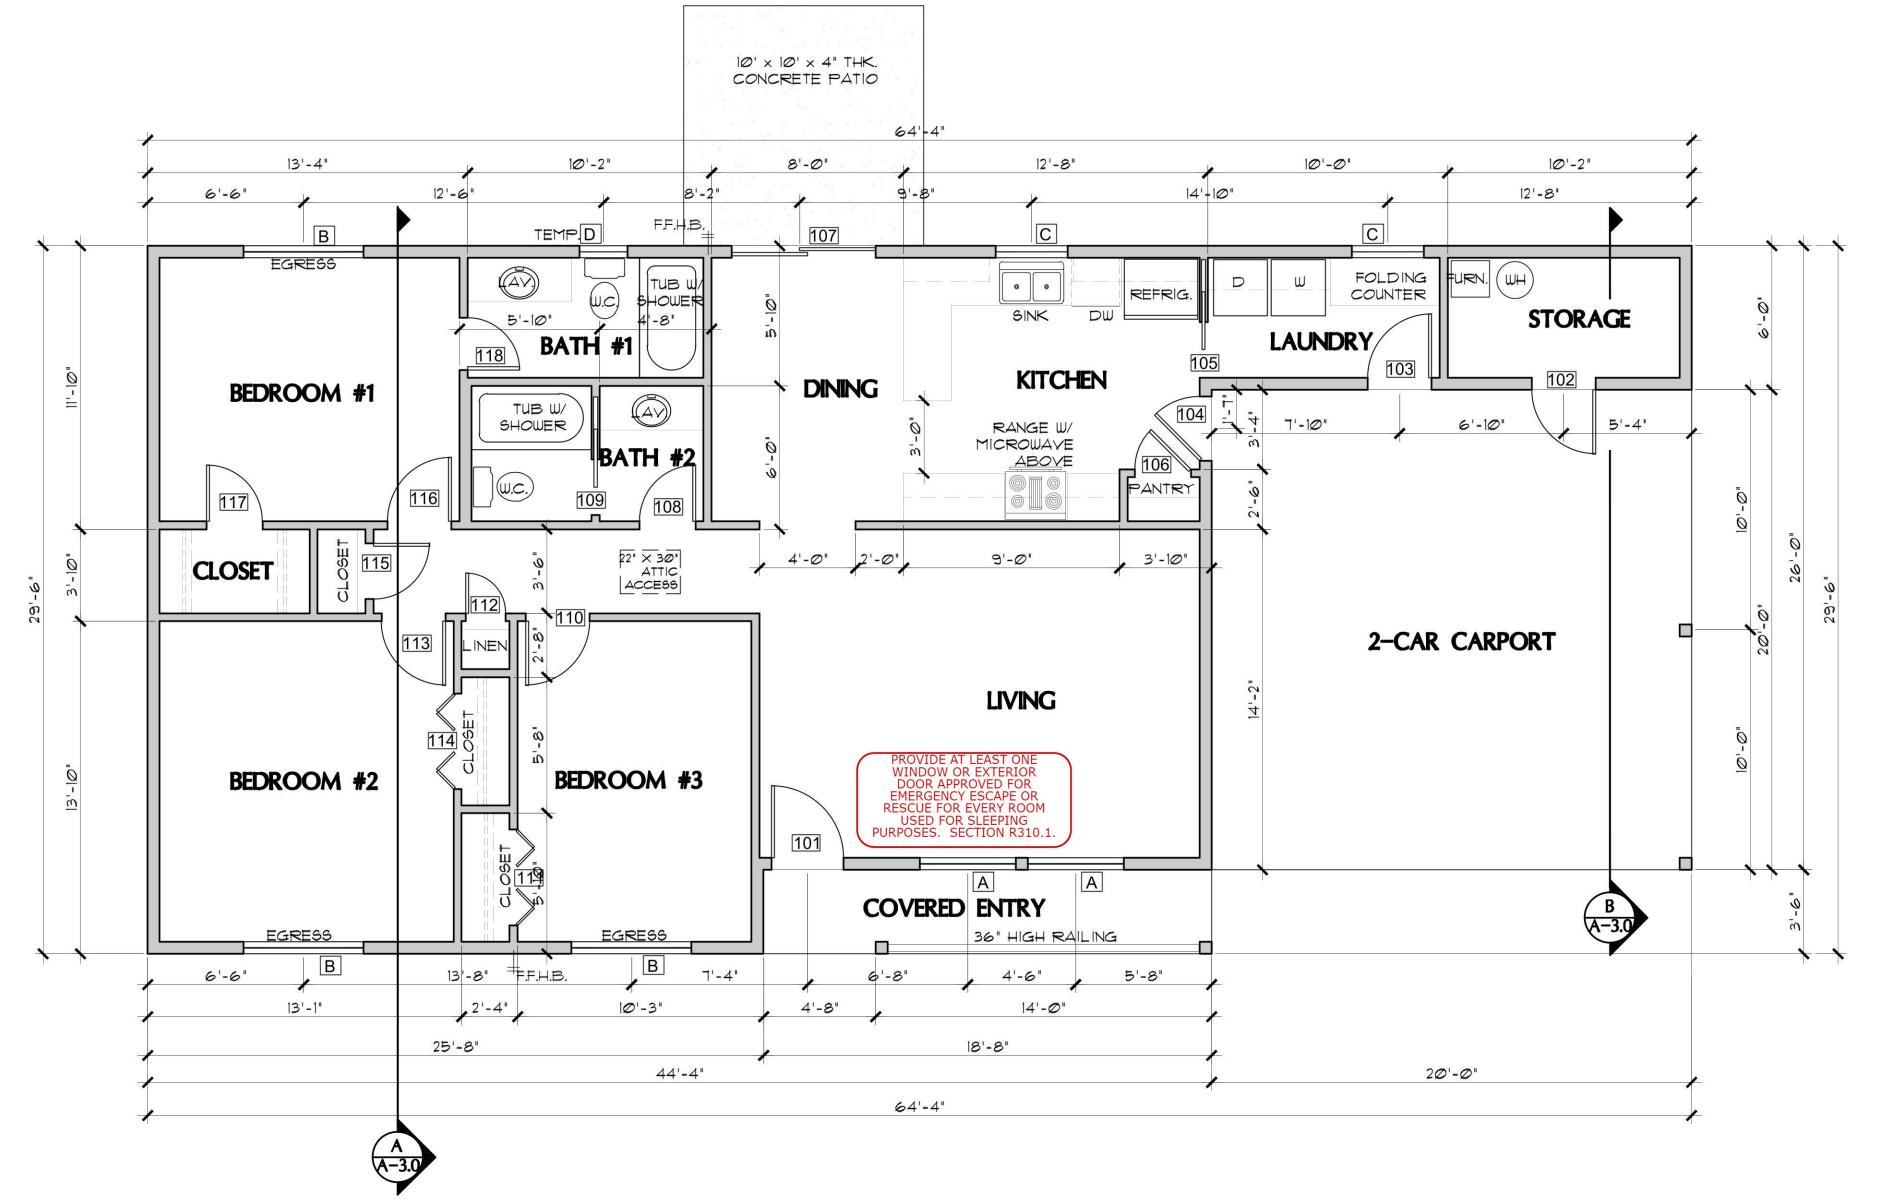

FLOOR PLAN (see sheet A-1.1 for Garage Alternate) SCALE: 1/4" = 1'-0"

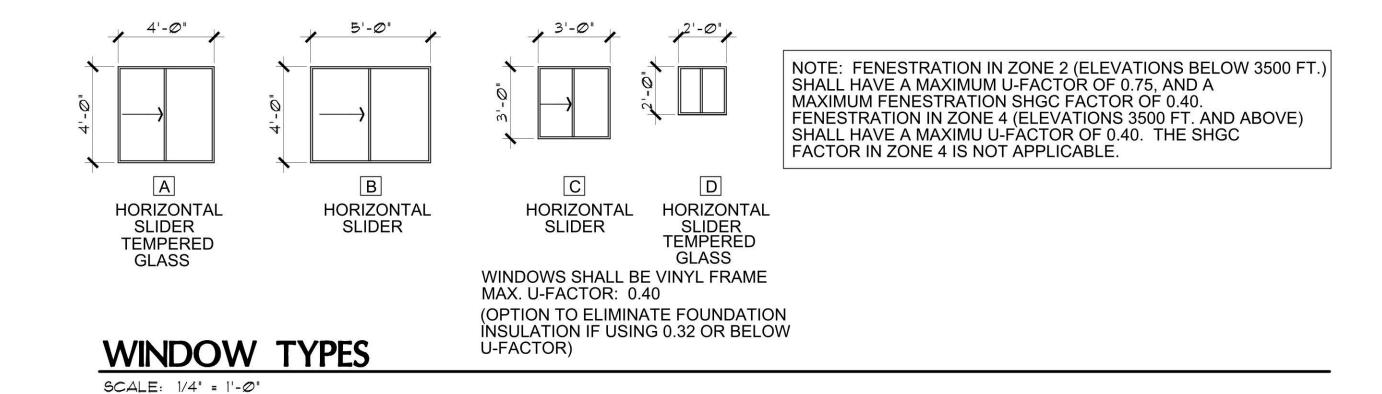

DR.	OR. SIZE			DOOR TYPE	
#	W.	H.	T.		REMARKS
101	3'-0"	6'-8"	1-3/4"	EXTERIOR 6-PANEL SOLID-CORE WOOD	
102	2'-8"	6'-8"	1-3/4"	EXTERIOR FLUSH SOLID-CORE WOOD	
103	2'-8"	6'-8"	1-3/4"	EXTERIOR FLUSH SOLID-CORE WOOD	
104	6'-8	6'-8"	1-3/4"	2-PANEL SOLID-CORE WOOD W/ TEMPERED GLASS VISION PANEL	SELF-CLOSING & SELF-LATCHING PROVIDE THRESHOLD AND WEATHERSTRIPPING
105	2'-4"	6'-8"	1-3/8"	INTERIOR 4-PANEL SLIDING POCKET DOOR	
106	3'-0"	6'-8"	1-1/2"	INTERIOR 4-PANEL HOLLOW CORE	
107	6'-0"	6'-8"	-	EXTERIOR SLIDING-GLASS PATIO DOOR	
108	5'-0"	6'-8"	1-1/2"	INTERIOR 4-PANEL HOLLOW CORE	
109	5'-0"	6'-8"	1-3/8"	INTERIOR 4-PANEL SLIDING POCKET DOOR	
110	2'-8"	6'-8"	1-1/2"	INTERIOR 4-PANEL HOLLOW CORE	
111	4'-0"	6'-8"	1-1/8"	INTERIOR 4-PANEL BI-FOLD	
112	1'-8"	6'-8"	1-1/2"	INTERIOR 4-PANEL HOLLOW CORE	
113	2'-8"	6'-8"	1-1/2"	INTERIOR 4-PANEL HOLLOW CORE	
114	4'-0"	6'-8"	1-1/8"	INTERIOR 4-PANEL BI-FOLD	
115	2'-4"	6'-8"	1-1/2"	INTERIOR 4-PANEL HOLLOW CORE	
116	2'-8"	6'-8"	1-1/2"	INTERIOR 4-PANEL HOLLOW CORE	
117	2'-4"	6'-8"	1-1/2"	INTERIOR 4-PANEL HOLLOW CORE	
118	2'-4"	6'-8"	1-1/2"	INTERIOR 4-PANEL HOLLOW CORE	



Date Drawn by:

Scale

Revisions:

Chk'd by : MFR

: AS NOTED

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Scales as stated hereon are valid on the original drawing only. Contractor shall carefully review all dimensions and conditions shown hereon and at once report to the Architect any error, inconsis—

tancy or omission he may discover.


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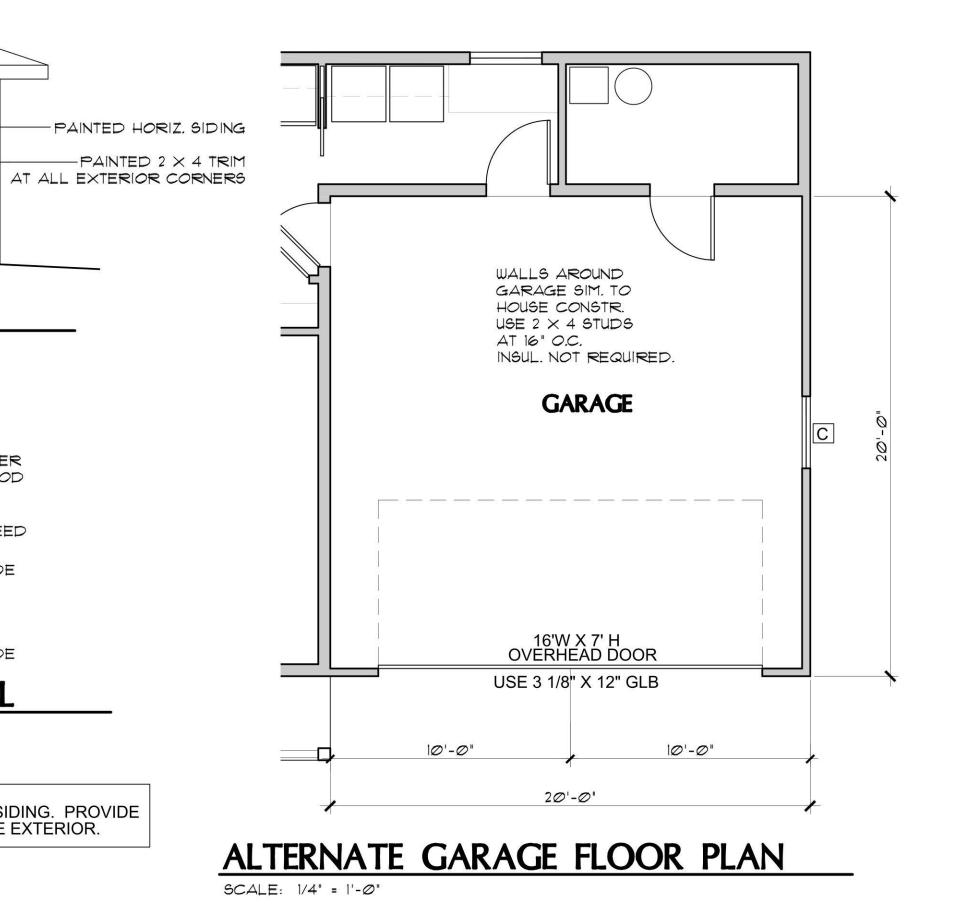
PARKING


PROJECT INFO / OPENING BEDROOM / 2 BA

SHEET NO:


A-1.0



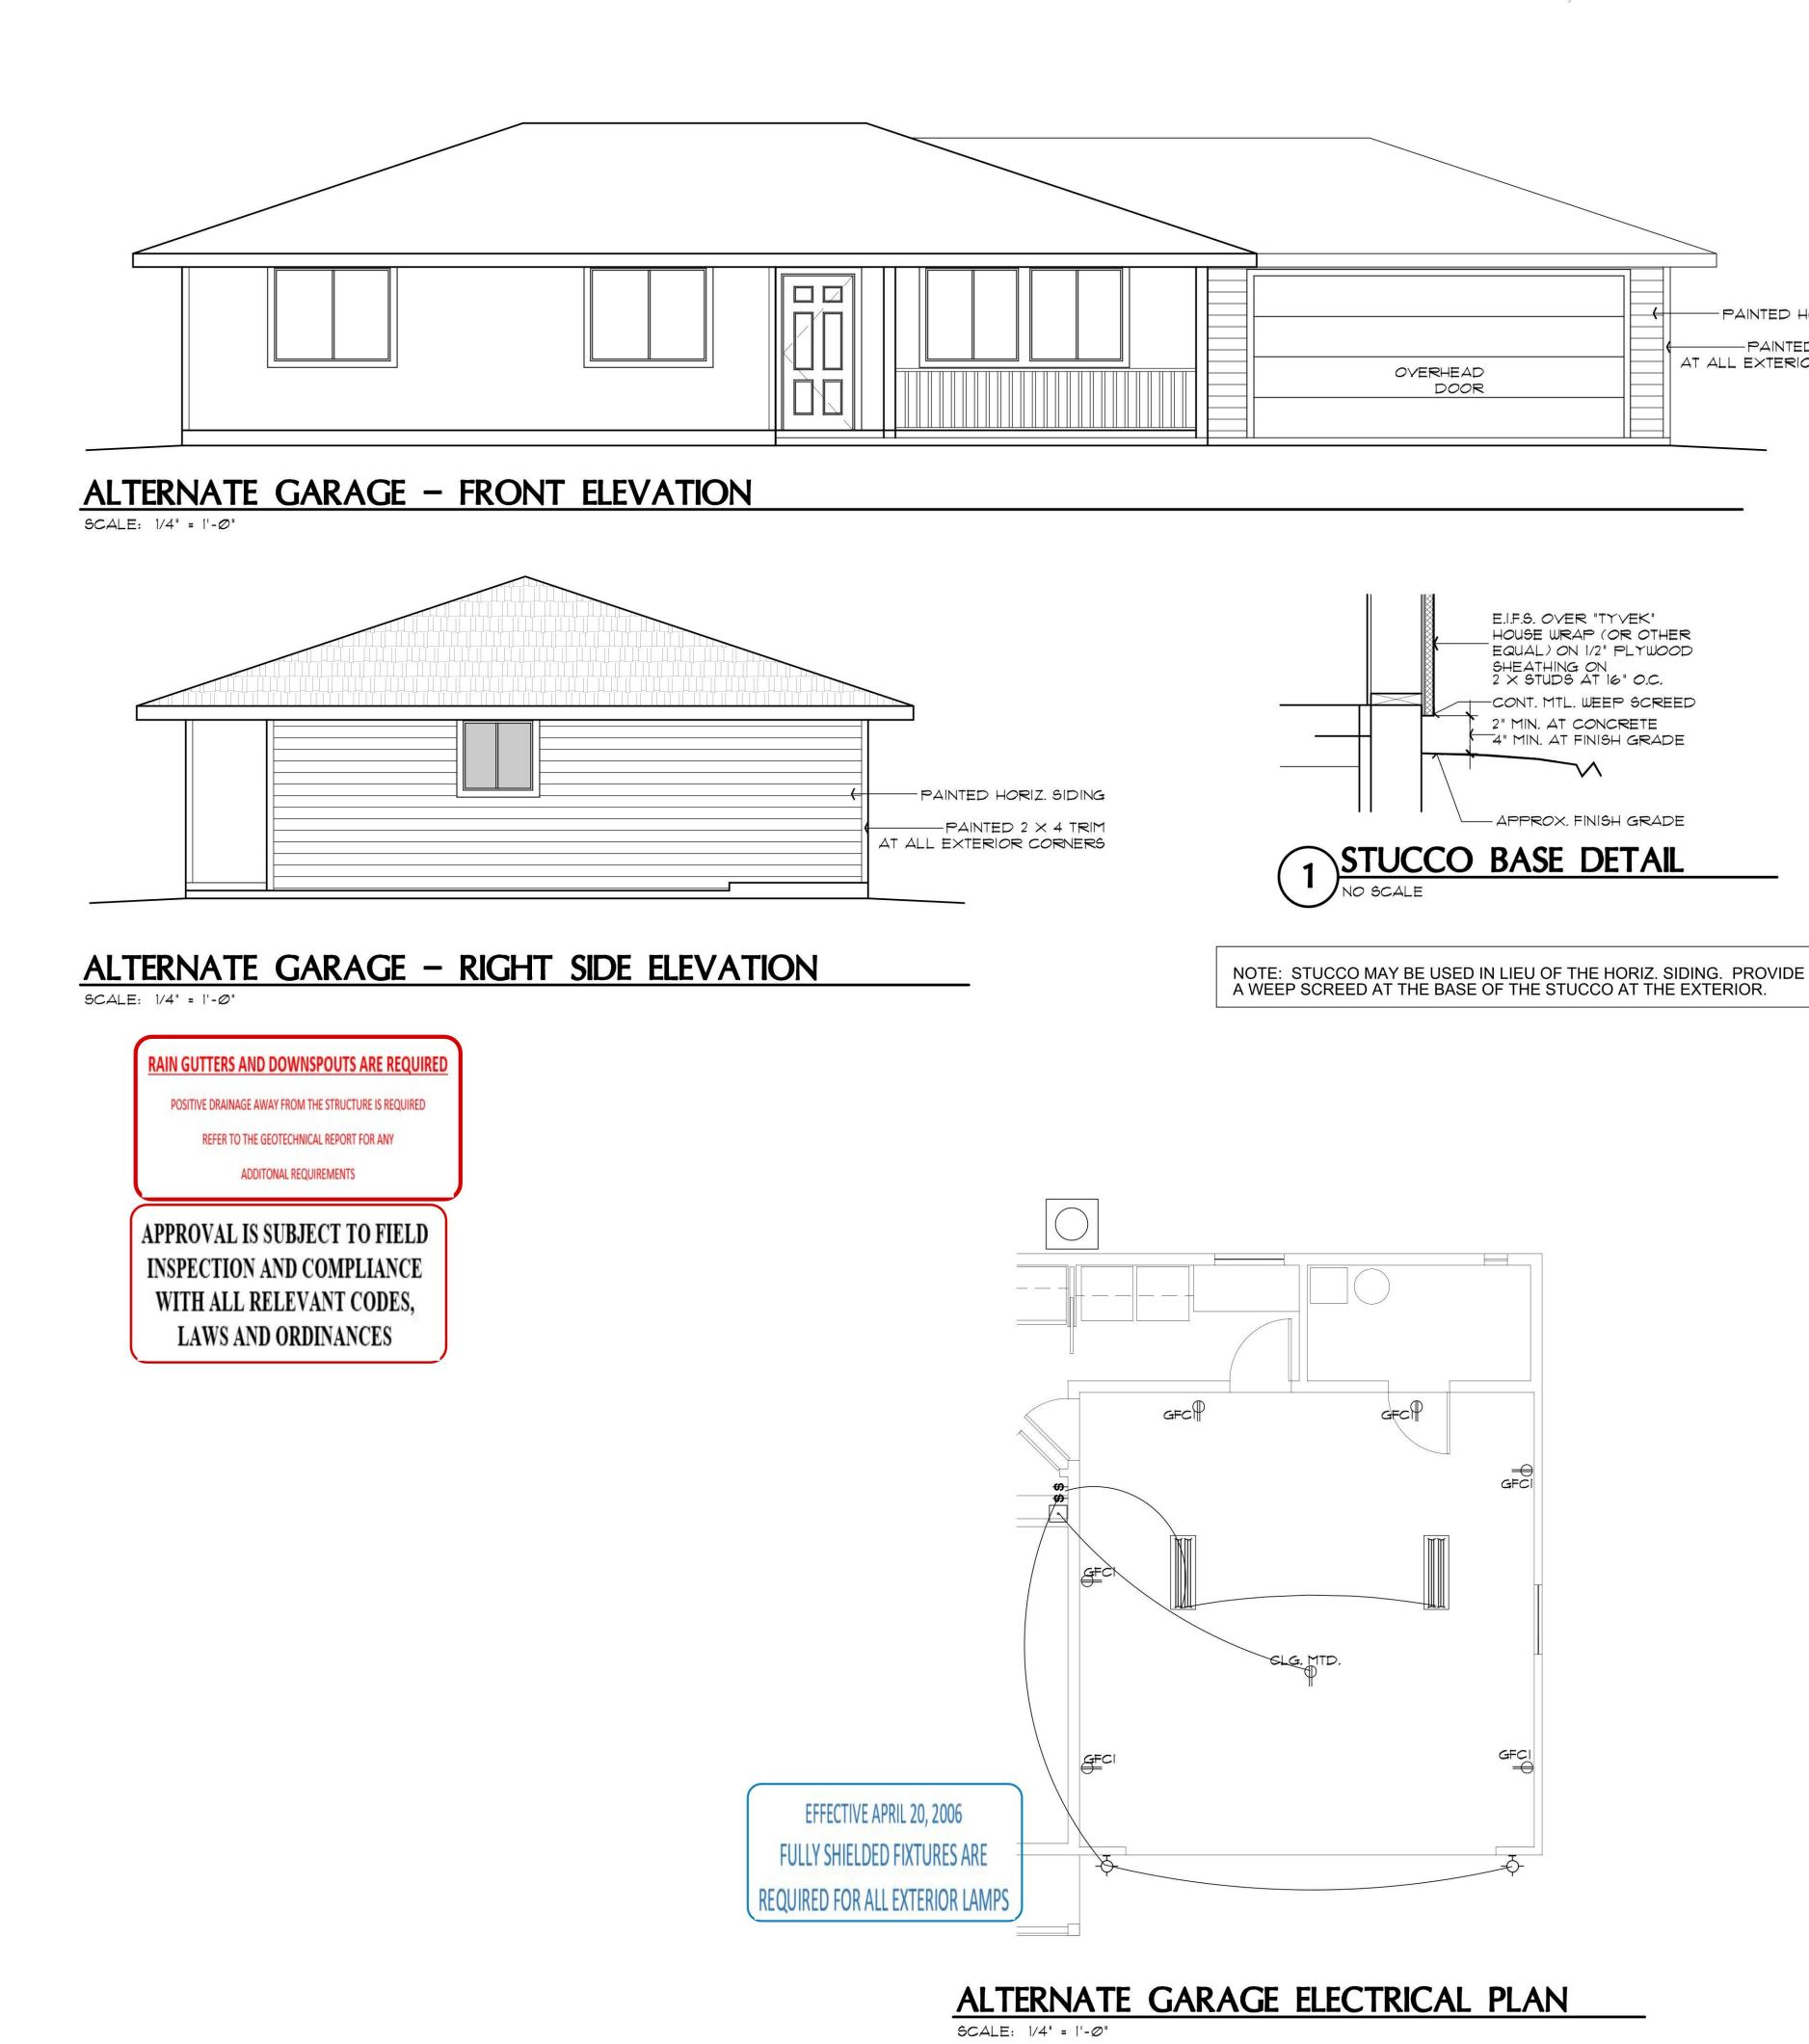

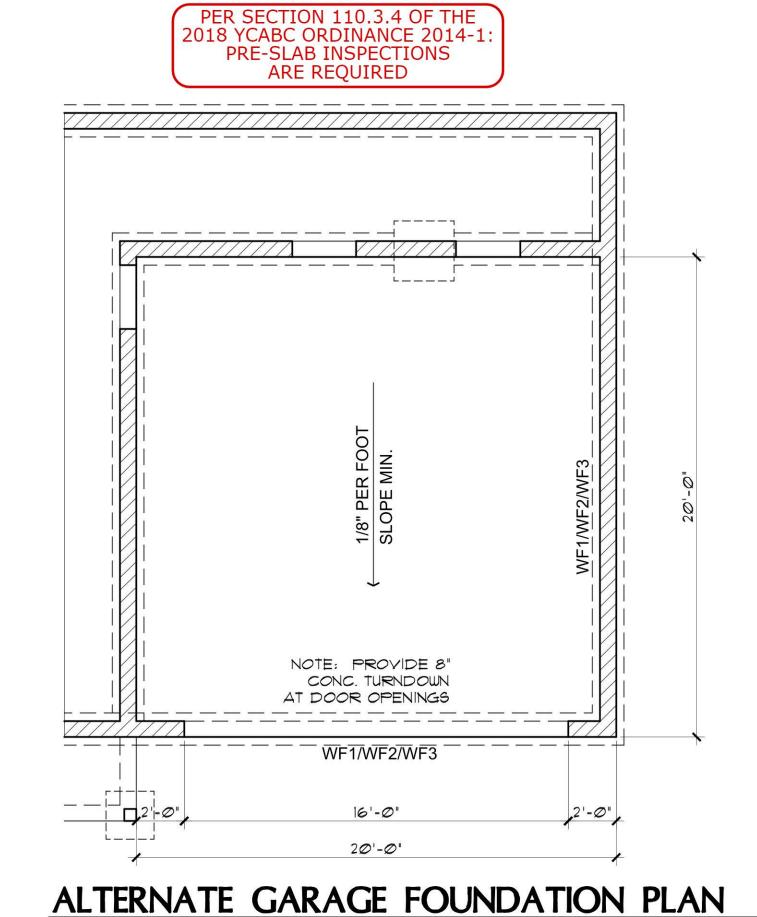

SCALE: 1/4" = 1'-0"

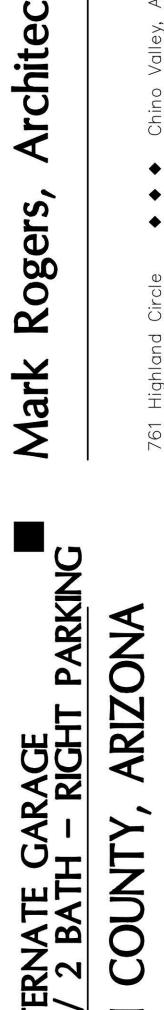

Drawn by: MFR Chk'd by: MFR

Scale : Revisions:

PLL

: AS NOTED

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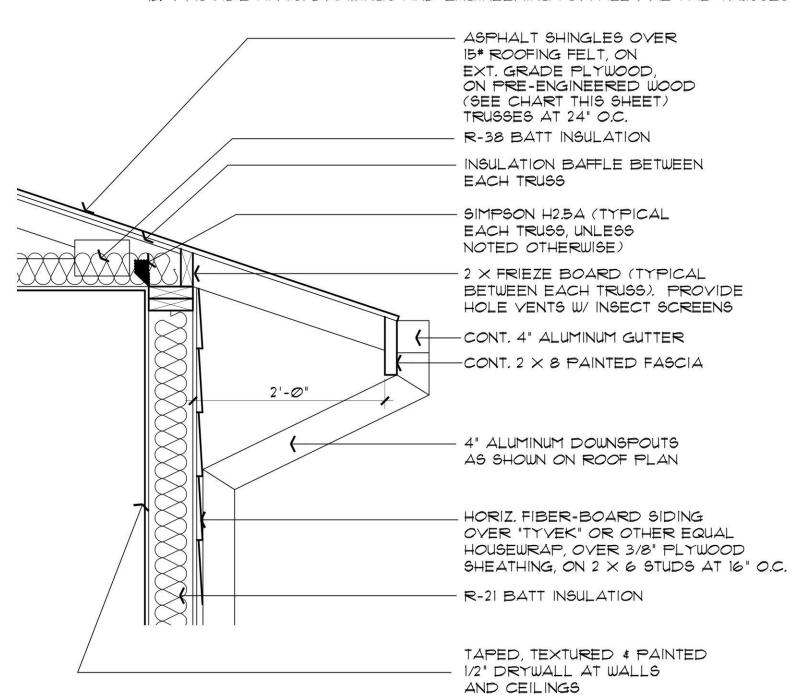
AEDROOM SHEET NO:


YAVAPA

- 2. SIMPSONS H2.5A HANGERS TO BE APPLIED @ ALL TRUSS
- 3. PROVIDE A MINIMUM OF 1 SQ. FT. OF ATTIC VENTILATION FOR EACH 150 SQ. FT. OF ATTIC SPACE.
- 4. ALL PLYWOOD SHEATHING STD. GRADE 5/8" CDX NAIL 8d @ 6" EDGES -12" FIELD STAGGER JOINTS.
- 5. SUPPORTED MEMBERS OF G.L.B. & GIRDERS OR OTHER CONCENTRATED LOADS SUPPORTED BY WALL OR PIER SHALL HAVE BEARING AT LEAST AS WIDE AS THE ROOF
- 6. ROOF PITCH 4:12 (TYP.).


ROOF NOTES

- 7. OVERHANGS TO BE 24".
- 8. FURNACE IN ATTIC: PROVIDE A 24" SOLID PASSAGEWAY TO CONTROL SIDE OF APPLIANCE AND A 30" SERVICE SPACE ON THE CONTROL SIDE OF THE APPLIANCE (REQUIRED FOR ATTIC MOUNT FURNACES)
- 9. ALL OVER FRAMING REQUIRES SLEEPER OR BLOCKING AND COLLAR TIES
- 10. ALL RAFTERS SHALL BE DOUGLAS FIR #2 (SIZE PER PLAN) ALL STUDS SHALL BE HEM FIR #2 (SIZE PER PLAN)
- 11. PROVIDE TEMP. BRACING, SHORING AND GUTTING TO AVOID EXCESSIVE STRESSES AND TO HOLD STRUCTURAL ELEMENT IN PLACE DURING ERECTION.
- 12. PROVIDE MFR'S, DRAWINGS AND ENGINEERING FOR ALL PRE-FAB TRUSSES



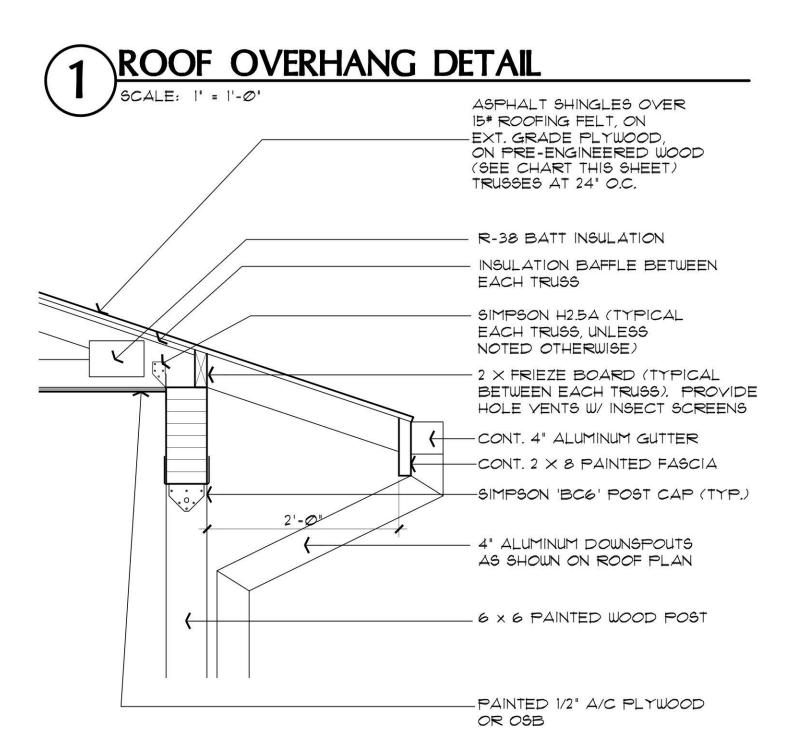

ROOF OVERHANG AT CARPORT BEAM DETAIL SIM. CONDITION AT FRONT ENTRY

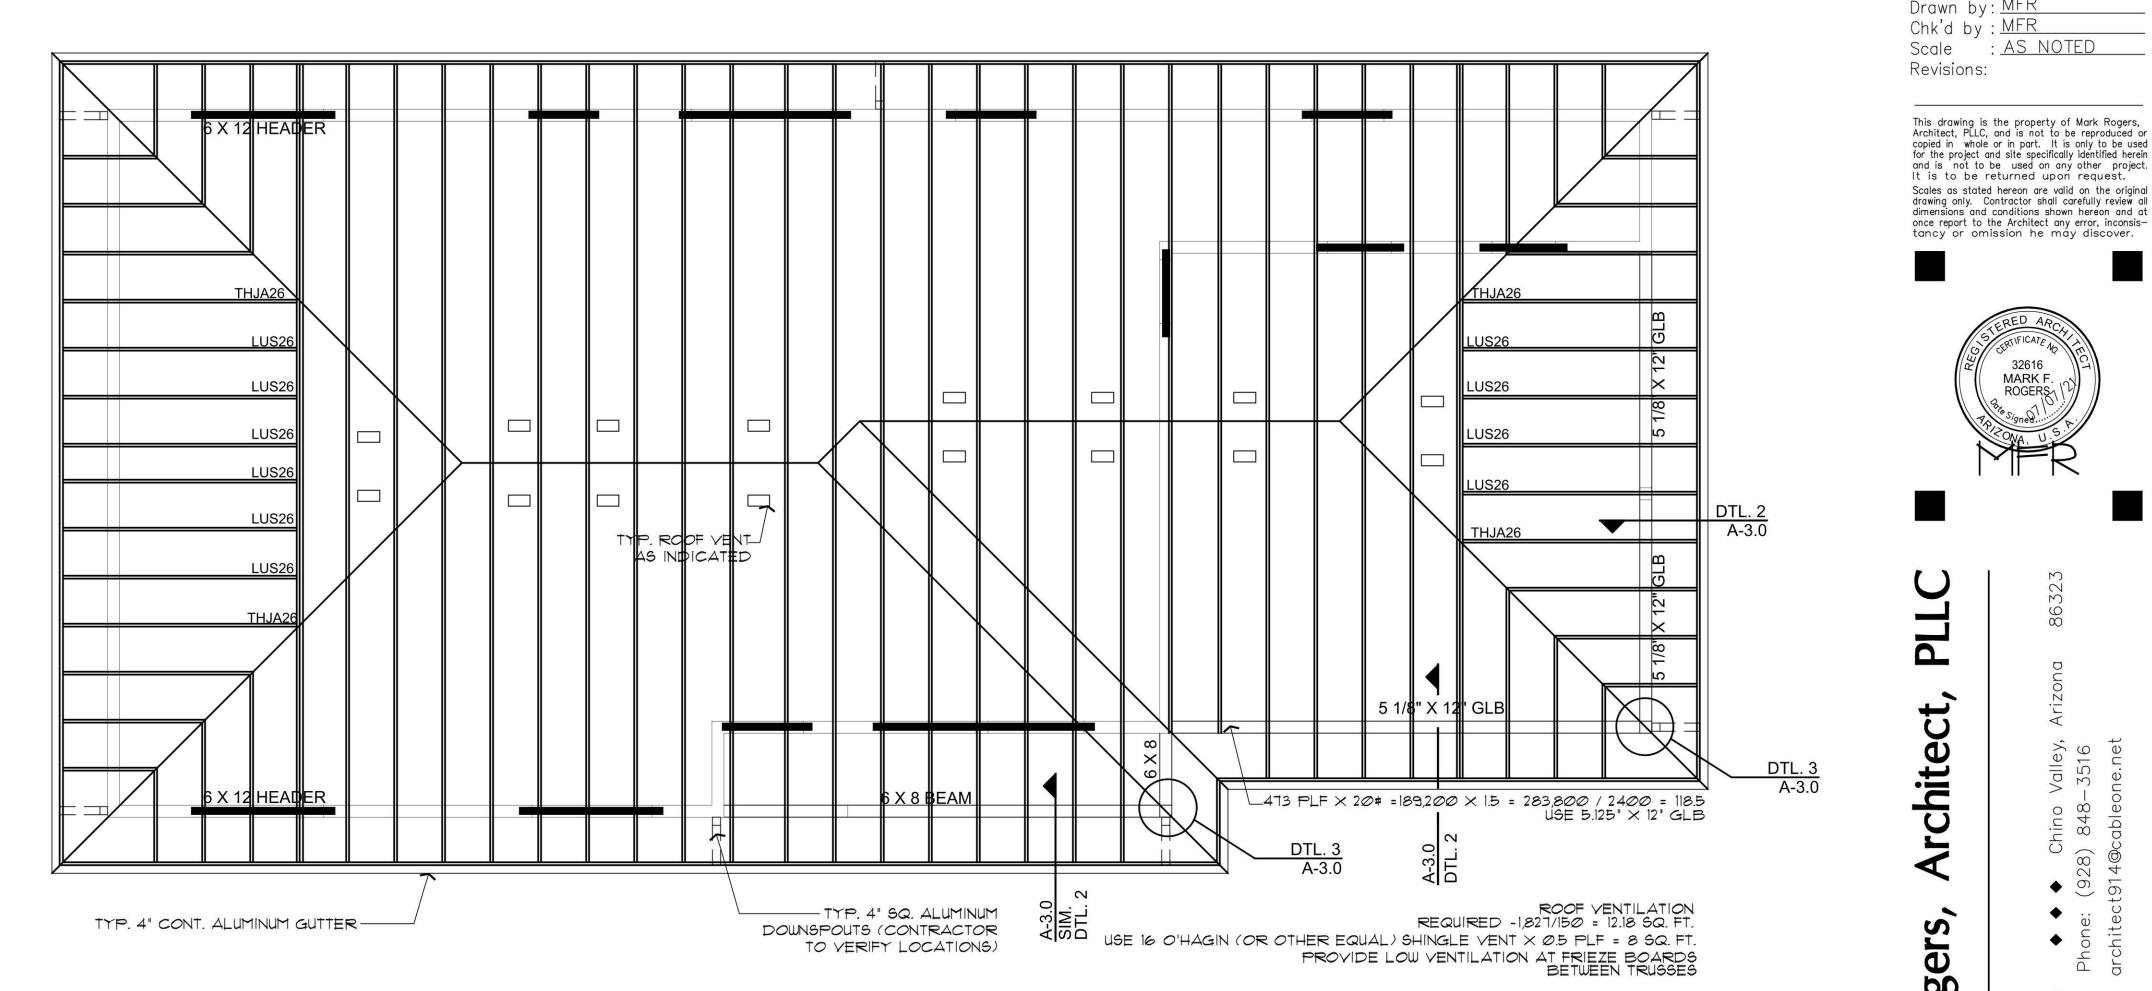

ROOF FRAMING PLAN

SCALE: 1/4" = 1'-0"

TO BE ON SITE AT TIME OF INSPECTION

APPROVAL IS SUBJECT TO FIELD INSPECTION AND COMPLIANCE WITH ALL RELEVANT CODES, LAWS AND ORDINANCES


NOTE: ALL OPENING HEADERS AT EXT. WALLS TO BE 6 X 8 UNLESS NOTED OTHERWISE

NOTE: PROVIDE PANEL EDGE SUPPORT FOR NARROW-WIDTH ROOF SHEATHING PER APA TECHNICAL REPORT #R275A.


NOTE: TRUSS-TO-GIRDER DOUBLE STUDS UNDER | CONNECTIONS TO BE TWO-PLY GIRDER TRUSSES SIMPSON HTU26 OR OTHER

Yavapai County Snow Load by Elevation

ELEVATION	SNOW LOAD	FOOTING DEPTH	ROOF SHEATHING
5000 ft. and Below	20 PSF	12" below 4500 ft. 18" above 4500 ft.	1/2"
5001 ft. to 5900 ft.	30 PSF*	18"	1/2"
5901 ft To 6200 ft.	40 PSF*	18"	½" or 5/8" With tile over 60#TL
6201 ft. to 6500 ft.	45 PSF*	18"	5/8"
Over 6501 ft.	50 PSF*	24"	5/8"

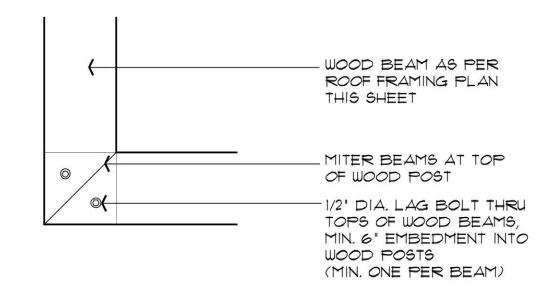

PLAN VIEW - MITERED BEAM AT CORNER POSTS CONNECTION

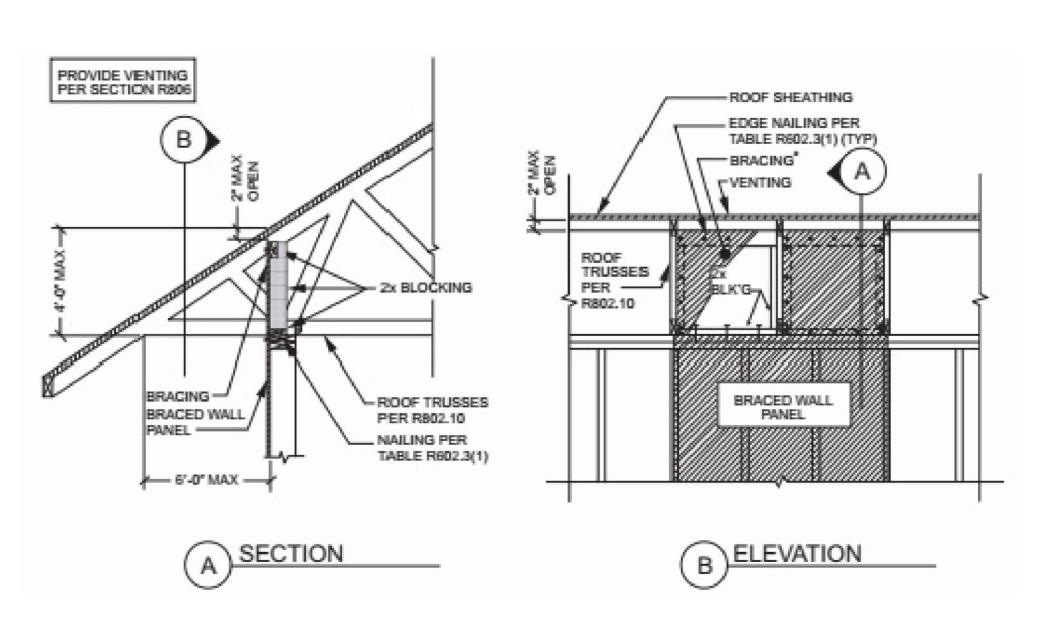

BRACED WALL PANEL CONNECTION OPTION

AT PERPENDICULAR ROOF TRUSSES

2018 IRC FIGURE
2018 IRC FIGURE

2018 IRC FIGURE R602.10.8.2(3)

REVIEWED FOR DESIGN CRITERIA ONLY

PROPERTY OF YAVAPAI COUNTY. AZ

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ROGERS_

MARK F

ARIZONA

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Chk'd by : MFR

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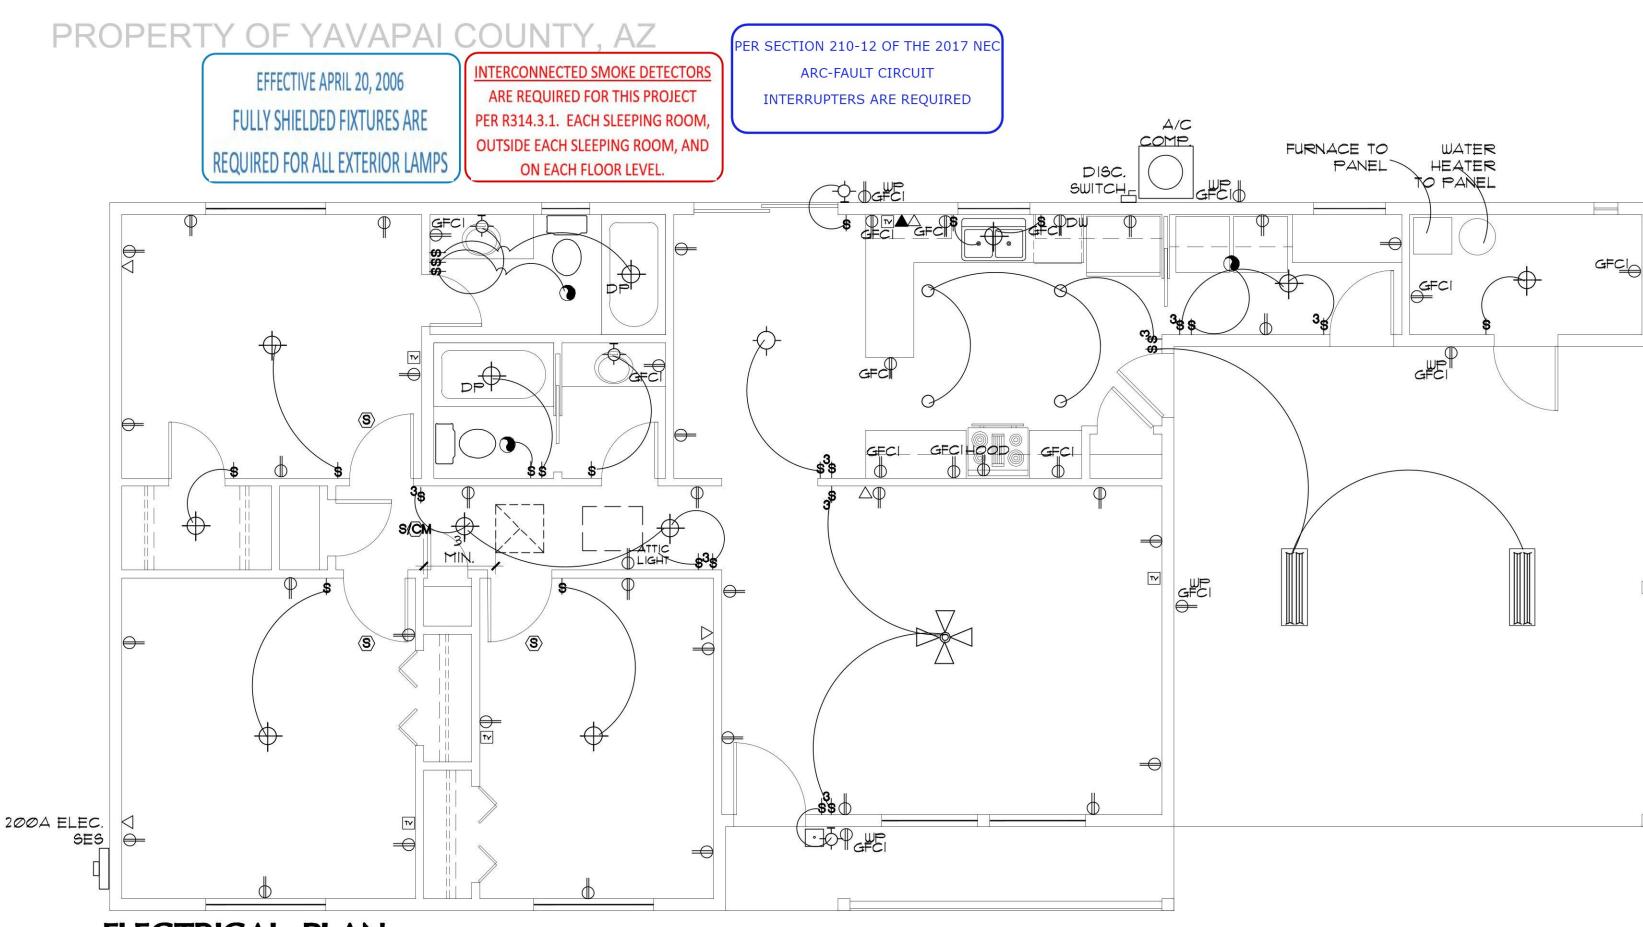
-CEILING FAN W/ LIGHT KIT

- DOORBELL BUTTON

--- TELEPHONE OUTLET

ELECTRICAL GENERAL NOTES

- 1. ALL WORKMANSHIP, MATERIALS, AND METHODS SHALL CONFORM TO N.E.C. - 2017 EDITION.
- 2. ALL HABITABLE ROOMS SHALL BE PROVIDED W/ ELECTRICAL OUTLETS SO THAT NO PART OF THE WALL IS MORE THAN 6' FROM AN OUTLET. WALL SECTIONS 2' OR LARGER & KITCHEN COUNTERS WIDER THAN 12" SHALL BE SERVICED BY A RECEPTACLE.
- 3. ALL RECEPTICALS IN BATHROOMS, OUTSIDE & WITHIN 6' OF WATER SOURCE SHALL BE G.F.C.I.
- 4. ALL SMOKE DETECTORS SHALL BE INTERCONNECTED ON SEPARATE CIRCUIT & SHALL RECEIVE PRIMARY POWER FROM BUILDING WIRING & SHALL HAVE BATTERY BACKUP, CONNECT NEW SMOKE DETECTORS TO NEW AUDIBLE SYSTEM INSIDE EXISTING RESIDENCE.
- 5. LIGHTS IN CLOSETS SHALL BE 18' FROM SHELVING (MEASURED HORZTL. OR BE RECESSED.
- 6. PROVIDE MINIMUM TWO 20A BRANCH CIRCUITS FOR RECEPTACLES LOCATED IN THE KITCHEN, PANTRY, EATING AREA, A SEPARATE 2014 BRANCH CIRCUIT TO THE LAUNDRY EQUIP., AND A SEPARATE 20A BRANCH CIRCUIT FOR BATHROOM RECEPTACLES.
- 7. ALL BRANCH CIRCUITS THAT SUPPLY 120-VOLT SINGLE PHASE 15 & 20 AMP OUTLETS INSTALLED IN FAMILY ROOMS, DINING ROOMS LIVING ROOMS, PARLORS, LIBRARIES, DENS, BEDROOMS, SUNROOMS RECREATION ROOMS, CLOSETS, HALLWAYS AND SIMILAR ROOMS OR AREAS SHALL BE PROTECTED BY COMBINATION TYPE ARC FAULT CIRCUIT INTERUPTERS INTALLED TO PROVIDE PROTECTION OF THE BRANCH CIRCUIT.
- 8. FIXTURES, FITTINGS, BOXES AND RECEPTACLES LOCATED IN DAMP OR WET LOCATIONS SHALL BE 'LISTED' TO BE SUITABLE FOR SUCH CONDITIONS.
- 9. CONTRACTOR TO EMBED 20' OF #4 GA. COPPER WIRE IN FOOTING FOR ELECTRICAL SERVICE GROUND. PROVIDE BONDING TO THE INTERIOR WATER PIPING AND ABOVE GROUND PORTION OF GAS PIPING SYSTEM.
- 10. IN KITCHEN AND DINING ROOMS A RECEPTACLE OUTLET SHALL BE INSTALLED AT EACH WALL COUNTER SPACE 12" OR WIDER SO THAT AT NO POINT ALONG THE WALL IS MORE THAN 24" FROM A RECEPTACLE OUTLET AND SHALL BE GFCI PROTECTED.
- 11. PROVIDE AT LEAST ONE WEATHER PROOF RECEPTACLE OUTLET NOT MORE THAN 6'-6" ABOVE GRADE AND GFCI PROTECTED. AT THE FRONT AND BACK OF EACH DWELLING. ALL RECEPTACLES INSTALLED OUTDOORS MUST BE GFCI PROTECTED.
- 12. ALL EXTERIOR LIGHTING SHALL CONFORM TO YAVAPAI COUNTY DARK SKY ORDINANCE.
- 13. IN ATTICS, A SERVICE OUTLET & LIGHTING FIXTURE LOCATED NEAR THE APPLIANCE REQUIRING SERVICE SHALL BE CONTROLLED BY A SWITCH AT THE ENTRY OF THE ATTIC. (REQUIRED FOR ATTIC MOUNT FURNACES)
- 14. ALL ELECTRICAL FIXTURES SHALL BE LISTED, AND LABELED ('UL' OR OTHER EQUAL TESTING).



ELECTRICAL PLAN

SCALE: 1/4" = 1'-0"

ENERGY NOTES:

*FENESTRATION U-FACTOR WINDOW AND DOORS TO BE .40 STICKER SHALL REMAIN ON WINDOWS, SKYLIGHTS & DOORS UNTIL INSPECTED AND APPROVED FOR THE ABOVE REQUIREMENT. THE FOUNDATION SLAB INSULATION MAY BE ELIMINATED IF USING A MAX. 0.32 U-FACTOR ON GLAZING.

2. CEILINGS

MARKERS SHALL BE AFFIXED TO THE TRUSSES OR JOIST AND MARKED WITH THE MIN. ISTALLED THICKNESS BY ONE INCH HIGH NUMBERS. A MIN. OF ONE MARKER SHALL BE INSTALLED 6. FENESTRATION AIR LEAKAGE FOR EVERY 300 SQ. FT. OF AREA WITH NUMBERS TO FACE THE ATTIC ACCESS OPENING. MARKERS MUST BE INSTALLED AT ROUGH IN OR WALL INSULATION INSPECTIONS.

WOOD FRAMED EXTERIOR WALLS (MIN. R-19 FOR 2 X 6 WALLS) * WALL INSULATION SHALL BE IN SUBSTANTIAL CONTACT WITH THE SURFACE BEING INSULATED TO AVOID AIR PATHS THAT BYPASS THE INSULATION.

* INSULATION SHALL NOT BE COMPRESSED BY INSET STAPLING OF THE BATT INSULATION OR OTHER MEANS * INSULATION SHALL FILL ALL CAVATIES COMPLETLY BY CUTTING INSULATION AROUND ELECTRCAL OUTLETS AND SWITCHES AND BY SLICING INSULATION TO FIT BEHIND AND IN FRONT OF ELECTRICAL WIRING IN THE CAVITY AND PLUMBING PIPING * BAND JOISTS AND OTHER INTERSTITIAL FLOOR ELEMENTS

4. NOT USED.

5. BUILDING THERMAL ENVELOPE

THE SEALING METHODS BETWEEN DISSIMILAR MATERAILS SHALL ALLOW FOR DIFFERENTAIL EXPANSION AND CONTRACTION. THE FOLLOWING SHALL BE CAULKED, GASKETED WEATHER STRIPPED OR OTHERWISE SEALED WITH AN AIR BARRIER MATERIAL, SUITABLE FILM OR SOLID MATERIAL:

A. ALL JOINTS, SEAMS AND PENETRATIONS. B. SITE BUILT WINDOWS, DOORS AND SKYLIGHTS OPENINGS BETWEEN WINDO AND DOOR ASSEMBLIES AND THEIR RESPECTIVE JAMBS AND FRAMING. UTILITY PENETRATIONS.

- DROPPED CEILINGS OR CHASES ADJACENT TO THE THERMAL ENVELOPE. F. KNEE WALLS
- G. WALLS AND CEILINGS SEPERATING GARAGE FROM CONDITIONED SPACES. BEHIND TUB AND SHOWERS ON EXTERIOR WALLS * CEILING INSULATION TO BE MIN. R-30 (ZONE 2); R-38 (ZONE 4) | COMMEN WALLS BETWEEN DWELLING UNITS J. OTHER SOURCES OF INFILTRATION.

* WINDOW, SKYLIGHT AND SLIDING GLASS DOOR SHALL HAVE AN AIR INFILTRATION RATE OF NO MORE THAN 0.3 CFM PER SQUARE FOOT, AND SINGING DOORS NO MORE THAN 0.5 CFM. SPECIFICATIONS SHALL BE LISTED ON THE MANUF. LABEL. (USE TYVEK HOUSE WRAP, INSTALL PER MANUF. SPECS)

. RECESSED LIGHTING

RECESSED LUMINAIRES INSTALLED IN THE BUILDING THERMAL ENEVELOPE SHALL BE SEALED TO LIMIT AIR LEAKAGE BETWEEN CONDITIONED AND UNCONDITIONED SPACES BY

A. 1C RATED AND LABELED WITH ENCLOSURES THAT ARE SEALED OR GASKETED TO PREVENT AIR LEAKAGE TO CEILING CAVITY OR UNCONDITIONED SPACE; OR B. IC RATED AND LABELED AS MEETING ASTM E 283; OR C. LOCATED INSIDE AIRTIGHT SEALED BOX WITH CLEARANCES 15. EQUIPTMENT SIZING OF AT LEAST 0.5 INCH FROM COMBUSTIBLE MATERIAL AND

8. HEAT PUMP SUPPLEMENTARY HEAT

3 INCHEDS FROM INSULATION.

- * HEAT PUMPS HAVING SUPPLEMENTARY ELECTRIC- RESISTANCE HEAT SHALL HAVE CONTROLS THAT, EXCEPT DURING DEFROST PREVENT SUPPLEMENTAL HEAT OPERATION WHTN THE HEAT PUMP COMPRESSOR CAN MEET THE HEATING LOAD.
- * AT LEAST ONE THERMOSTAT SHALL BE PROVIDED FOR EACH SEPERATE HEATING & COOLING SYSTEM.

- * SUPPLY AND RETURN DUCTS SHALL BE INSULATED TO A MIN. OF R-8 (EXCEPT DUCTS THAT COMPLETLY INSIDE THE BUILDING THERMAL ENVELOPE.
- * ALL DUCTS, AIR HANDLERS, FILTER BOXES, AND BUILDING CAVITIES (NOT FOR AIR SUPPLY) USED AS DUCTS SHALL BE SEALED. JOINTS AND SEAMS SHALL COMPLY WITH SECTION M1601.3.1 OF THE IRC.
- 12. MECHANICAL SYSTEM PIPING INSULATION * MECHANICAL SYSTEM PIPING CAPABLE OF CARRYING FLUIDS ABOVE 105 D. F OR BELOW 55 D. F SHALL BE INSULATED TO A MIN. OF R-2

13. CIRCULATING HOT WATER SYSTEMS


- * ALL CIRCULATING SERVICE HOT WATER PIPING SHALL BE INSULATED TO AT LEAST R-2. ALL NEW RESIDENCES WITH 2 OR MORE BATHROOMS SHALL HAVE A CIRCULATING HOT WATER SYSTEM. CHWS SHALL INCLUDE AN AUTOMATIC OR READILY ACCESSIBLE MANUAL SWITCH THAT CAN TURN OFF THE HWCP WHEN THE SYSTEM IS NOT IN USE. THERMAL SIPHONING SYSTEMS SHALL HAVE A VALVE TO REDUCE FLOW. ALTERNATE SYSTEM SHALL BE CONSIDERED.
- 14. MECHANICAL VENTIALTION *OUTDOOR AIR INTAKES AND EXHAUST SHALL HAVE AUTOMATIC GRAVITY DAMPER THAT CLOSE WHEN THE VENTILATION SYSTEM

*HEATING & COOLING EQUIPTMENT SHALL BE SIZED IN ACCORDANCE WITH SECTION M1401.3 OF THE IRC.

16. AIR LEAKAGE

- AIR FLOW RETARDERS (HOUSE WRAPS) MUST BE: A. IMPERMEABLE TO AIR FLOW. B. CONTINOUS OVER THE ENTIRE BUILDING ENVELOPE
 - ABLE TO WITHSTAND THE FORCES THAT MAY ACT ON IT DURING AND AFTER CONSTRUCTION.

D. DURABLE OVER THE EXPECTED LIFETIME OF THE BUILDING E. ALL SEAMS AND EDGES MUST BE SEALED/TAPED PER MANUF SPECIFICATIONS

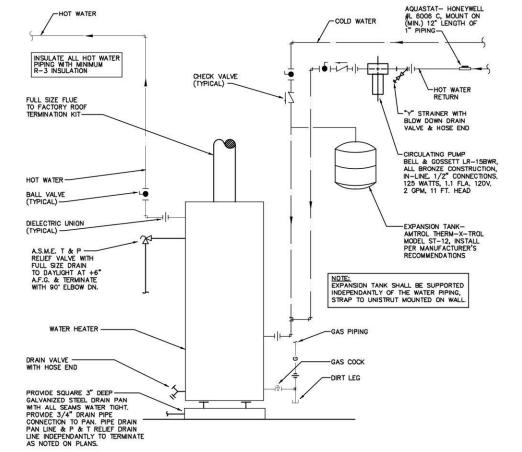

GAS WATER HEATER OPTION

WATER SIZE OF INCOMING WILL BE BASED ON DISTANCE TO GAS SQURCE. NOTE: INTERIOR

570 CFM

GAS LINES TO BE

MIN. 1/2"

HVAC PLAN SCALE: 1/4" = 1'-0"

415 CFM

F.F.H.B.

ATTIC

ACCESS

570 CFM

RXA

F.F.H.B.

RANGE

SUPPLY-AIR GRILL

THERMOSTAT

HVAC GENERAL NOTES:

A/C COMP. ON

415 CFM

, THE MECHANICAL CONTRACTOR SHALL DETERMINE THE FINAL EQUIPMENT SIZING, DUCT SIZING, AND DUCT LAYOUT PRIOR TO INSTALLATION. RETURN AIR GRILL 2. DRAIN AND VENT SIZES TO BE DETERMINED BY PLUMBING CONTRACTOR. 3. WATER HEATER RELIEF VALVE SHALL EXTEND OUTSIDE OF THE BUILDING WITH THE END OF THE PIPE NOT MORE THAN 2' NOR LESS THAN 6" ABOVE THE GROUND AND POINTING DOWNWARD.

4. PROVIDE A PAN, AND DRAIN FOR THE WATER HEATER.

INSPECTION AND COMPLIANCE

WITH ALL RELEVANT CODES,

LAWS AND ORDINANCES

THE HVAC CONTRACTOR SHALL REVIEW

PLANS/CALCULATIONS TO ASSURE DESIGN

S ADEQUATE AND COPMLIES WITH ALL APPLICABLE

CODES PRIOR TO INSTALLATION.

5. THE CLOTHES DRYER EXHAUST DUCT SHALL BE AT LEAST THE DIAMETER OF THE APPLIANCE OUTLET AS RECOMMENDED BY THE MANUFACTURER AND SHALL TERMINATE AT THE EXTERIOR OF THE BUILDING. IT SHALL NOT EXCEED 25' IN LENGTH WITH REDUCTIONS FOR BENDS. THE DUCT SHALL TERMINATE NOT LESS THAN 3' FROM A PROPERTY LINE.

TANK, AND RECIRCULATING SYSTEM FOR HOT WATER ar COMBUSTION AIR CALC: PROVIDE I SQ. IN. PER 4,000 BTU HTG. FIGURE 26,000 BTU HEATING DIVIDED BY 4000 = 6.5 MIN. SQ. IN. APPROVAL IS SUBJECT TO FIELD THE MECHANICAL EQUIPMENT, DESIGN AND SYSTEM HAVE BEEN REVIEWED FOR THE BASIC DESIGN **ONLY**

PROVIDE 12" SQ. COMBUSTION

T. \$ P.

DRAIN

AIR VENTS, ONE 12" ABOVE-

FLOOR, ONE 12' BELOW

PROVIDE EXPANSION

CEILING

ARKI MASTES RIGHT P. Ē SCREGO, 2 BATH

出

980

Date

Scale

Drawn by

Chk'd by:

Revisions:

MFR

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or the project and site specifically identified herein and is not to be used on any other project.

Scales as stated hereon are valid on the origina

dimensions and conditions shown hereon and at

once report to the Architect any error, inconsis-

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tancy or omission he may discover.

drawing only. Contractor shall carefully review a

It is to be returned upon request.

AS NOTED

ARIZ

SYMB(BEDROOM

3 SHEET NO:

OF THE WALL SHALL BE INSULATED

─ HOT WATER RETURN — S.O.V., (TYP) - UNION, TYPE - CHECK VALVE TYP. - T&P FULL-SIZE RELIEF LINE DRAIN TO EXTERIOR NOTE: DRAIN PAN, AND T&P + 4" SPACE ALL AROUND MUST DRAIN BY GRAVITY. WATER HEATER SHALL BE HIGH ENOUGH OFF THE FLOOR TO PROVIDE FOR EXTERIOR OF DISCHARGE PIPING TO EXTERIOR. GALV. DRAIN PAN

EXPANSION TANK (PROVIDE SUPPORT)

(24 GA. MIN.) ELECTRIC WATER HEATER DETAIL NO SCALE

NO SCALE

PROPERTY OF YAVAPAI COUNTY, AZ

GAS PIPING ISOMETRIC

REVIEWED FOR DESIGN CRITERIA ONLY

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